




VICINITY MAP (N.T.S.)

**SITE NOTES**

1. INSTALL GROUND PAINTED DIRECTIONAL TRAFFIC ARROWS. SEE SHT. C5.0, #10.
2. INSTALL PAINT STRIPES. SEE SHT. C5.1, #2.
3. INSTALL HIGH VISIBILITY PEDESTRIAN CROSSWALK STRIPING. SEE SHT. C5.1, #4.
4. INSTALL PARKING SPACE STRIPING/ADA ACCESSIBILITY SIGNAGE. SEE SHT. C5.1, #2.
5. INSTALL WHEEL STOPS. SEE SHT. C5.1, #2 & C5.4, #4.
6. INSTALL ACCESSIBLE NON-WING TYPE RAMP. SEE SHT. C5.1, #3.
7. INSTALL 24" CURB & GUTTER. SEE SHT. C5.1, #7.
8. INSTALL STANDARD CONCRETE SIDEWALK. SEE SHT. C5.1, #8.
9. INSTALL 6" STEEL BOLLARDS. SEE SHT. C5.4, #6.
10. INSTALL LIGHT DUTY ASPHALT PAVEMENT. SEE SHT. C5.2, #1.
11. INSTALL CONCRETE CURB TAPER. SEE SHT. C5.1, #9.
12. INSTALL TURN DOWN SIDEWALK. SEE SHT. C5.4, #3.
13. INSTALL CITY SIDEWALK. SEE SHT. C5.3, #SD-12.
14. INSTALL 6" SOLID FENCE. SEE SHT. C5.4, #2.
15. INSTALL CITY BUS STOP PAD. SEE SHT. C5.3, #SD-17.
16. INSTALL TRAFFIC "DO NOT ENTER" SIGN. SEE SHT. C5.1, #10.
17. INSTALL DOUBLE SIDEWALK FLUME W/ CONC. FLUME OUTLET. SEE SHT. C5.4, #1 & #7.
18. INSTALL ACCESSIBLE IN-LINE TYPE RAMP. SEE SHT. C5.4, #5.
19. INSTALL CITY ADA RAMP. SEE SHT. C5.3, #SD-2.7.
20. INSTALL CITY PAVEMENT. SEE SHT. C5.3, #SD-16.2.
21. INSTALL 4" THICK #57 STONE DRIVE TRANSITION.
22. SEE ARCHITECTURAL PLANS FOR PORCH AREA RAMPS.

**ADDITIONAL NOTES**

1. ALL GENERAL NOTES, ABBREVIATIONS, SYMBOLS, AND OTHER INFORMATION INDICATED ON COVER SHEET SHALL APPLY TO THIS PLAN. ALL ELEVATIONS SHOWN ARE IN REFERENCE TO THE BENCHMARK AND MUST BE VERIFIED BY THE GENERAL CONTRACTOR WITH THE SURVEYOR OF RECORD PRIOR TO BEGINNING CONSTRUCTION. BENCHMARK IS AN EXISTING CONCRETE MONUMENT LOCATED AT THE NORTHWEST CORNER OF PROJECT SITE, WITH COORDINATES (N 469,084.393, E 1,999,904.393 (NC GRID NAD 83 (2011)) AND HAVING AN ELEVATION OF 212.58 (NAVD 88).
2. TOTAL AREA: 110,990 SF (2.55 AC)
3. TOTAL PARKING SPACES = 70; 4 ADA VAN ACCESSIBLE SPACES

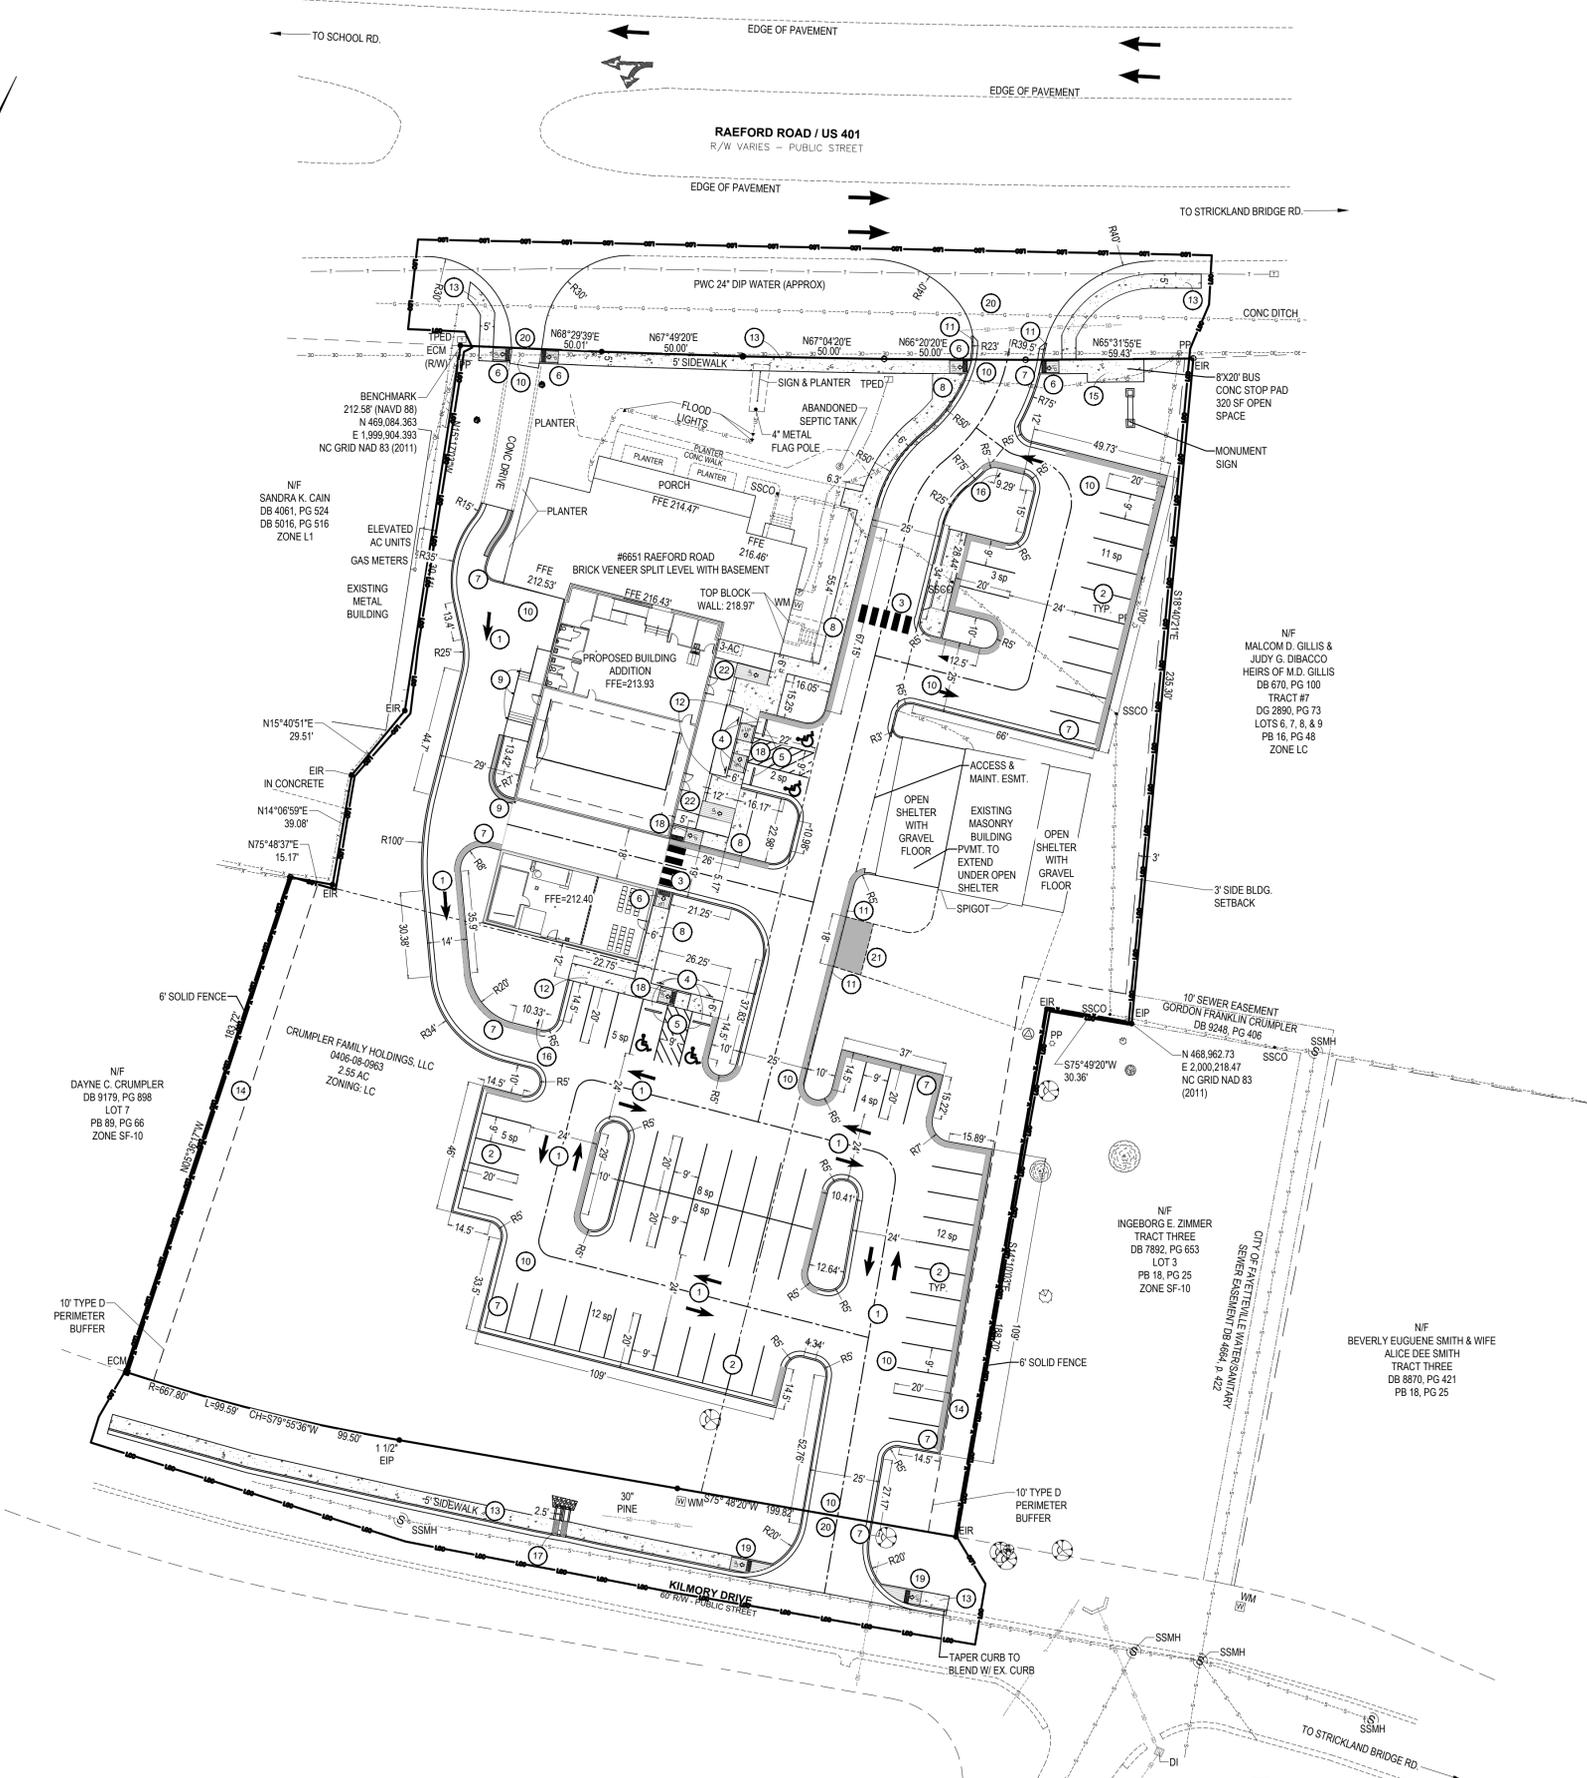

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PRELIMINARY

REVISIONS	Description
0	mm-dd-yy

LAFAYETTE FUNERAL HOME  
**LAFAYETTE FUNERAL HOME**  
BUILDING ADDITION

SITE LAYOUT PLAN

PROJECT DETAILS  
Project Manager: FDC  
CAD Technician: DJL  
Reviewed / Approved By: FDC  
Project Number: 21006

SCALE 0 30 60  
Full Scale: Horiz.: 1" = 30'

ISSUE DATE  
04/22/2021

SHEET NUMBER  
**C2.0**



VICINITY MAP (N.T.S.)

LANDSCAPE NOTES

- 1. MULCH LIMITS (SEE SHT. C5.3, #9&10)
  - 2. INSTALL BERMUDA SOG
  - 3. PERMANENT SEEDING
  - 4. INSTALL 3" PVC SLEEVES AT MINIMUM 18" DEPTH
1. ALL TREES SHALL BE MULCHED WITH A MINIMUM 6" PERIMETER UNLESS OTHERWISE INDICATED.
  2. CONTRACTOR SHALL USE HARDWOOD MULCH FOR ALL PLANTER BEDS UNLESS OTHERWISE INDICATED. THE USE OF ANY OTHER MULCHING MATERIAL MUST BE APPROVED BY THE DESIGNER PRIOR TO INSTALLATION. MULCH SHALL NOT COVER THE CROWN / ROOT FLARE OF THE PROPOSED PLANT MATERIAL.
  3. ALL PLANT MATERIAL SHALL BE APPROVED BY THE DESIGNER PRIOR TO ARRIVAL ON SITE. NO DEVIATIONS OR SUBSTITUTIONS FROM THE PLANT SCHEDULE SHALL BE ALLOWED WITHOUT WRITTEN APPROVAL FROM THE DESIGNER PRIOR TO THE ARRIVAL OF THE PLANT MATERIAL ON SITE.
  4. CONTRACTOR SHALL USE COMMERCIAL GRADE METAL EDGING FOR ALL PLANTER BEDS NOT ENCLOSED BY CONCRETE OR ASPHALT UNLESS OTHERWISE INDICATED. THE USE OF ANY OTHER EDGING MATERIAL SHALL BE APPROVED BY THE DESIGNER PRIOR TO INSTALLATION.
  5. TREES, SHRUBS & OTHER PLANTINGS SHALL MEET ALL LOCAL AND STATE REQUIREMENTS.
  6. ALL PLANTS MUST BE MULCHED WITHIN TWO (2) DAYS OF PLANTING BY COVERING THE ENTIRE PLANTING AREA WITH A 4-INCH THICK MINIMUM LAYER OF MULCH.
  7. ALL TREES SHALL BE AT LEAST 2" CALIPER AT TIME OF PLANTING UNLESS OTHERWISE SPECIFIED. ALL SHRUBS SHALL BE A MINIMUM SIZE OF THREE (3) GALLONS AT TIME OF PLANTING UNLESS OTHERWISE SPECIFIED.
  8. FOUNDATION PLANTINGS SHALL BE SPACED AN APPROPRIATE DISTANCE AWAY FROM BUILDING WALLS TO ASSURE PROPER MAINTENANCE AND GROWTH.
  9. CONTRACTOR SHALL BE RESPONSIBLE FOR INSTALLING AND MAINTAINING TREE PROTECTION FENCING AROUND ALL "AT-RISK" TREES WITHIN THE VICINITY OF THE CONSTRUCTION ACTIVITY WHETHER SPECIFICALLY INDICATED ON THE PLANS OR NOT. TREE PROTECTION FENCING SHALL BE INSTALLED PRIOR TO BEGINNING ANY CONSTRUCTION OR OTHER DEVELOPMENT ACTIVITIES, AND SHALL BE MAINTAINED AT ALL TIMES THROUGHOUT THE DURATION OF THE PROJECT UNTIL FINAL SITE INSPECTION.
  10. REFER TO CONSTRUCTION PLAN DETAIL SHEETS FOR TREE PROTECTION DETAIL(S). THE CONTRACTOR SHALL BE RESPONSIBLE FOR PROTECTING ALL PLANT MATERIAL AGAINST DAMAGE DURING THE CONSTRUCTION PERIOD. PROTECTION SHALL BEGIN FROM THE TIME THE PLANT MATERIAL IS INSTALLED AND SHALL CONTINUE UNTIL FINAL ACCEPTANCE OF THE PROJECT.
  11. ALL PLANT MATERIAL SHALL BE MAINTAINED UNTIL SUBSTANTIAL COMPLETION IS APPROVED BY THE OWNER. MAINTENANCE SHALL INCLUDE, BUT IS NOT LIMITED TO, WATERING, PRUNING, FERTILIZING, ETC.
  12. PRUNE PROPOSED TREES TO MAINTAIN 6-FT CLEAR UNDERSTORY HEIGHT.
  13. JUTE MESH SHALL BE PROVIDED ON ALL SLOPES GREATER THAN 3:1.
  14. IN THE EVENT OF A DISCREPANCY IN PLANT MATERIAL QUANTITIES BETWEEN THE DRAWINGS AND THE PLANT LISTS, THE LARGER QUANTITIES SHALL BE REQUIRED. THE CONTRACTOR SHALL SUPPLY PLANT MATERIAL IN QUANTITIES SUFFICIENT TO COMPLETE THE PLANTING AS SHOWN ON THE PLANS.
  15. THE CONTRACTOR SHALL LOCATE AND MARK ALL EXISTING AND PROPOSED UTILITIES TO VERIFY PROPOSED TREE LOCATIONS, AND SHALL REPORT ANY CONFLICTS TO THE DESIGNER TO DETERMINE ALTERNATE PLANTING LOCATIONS.
  16. STAKE ALL PROPOSED TREE PLANTINGS FOR REVIEW AND POTENTIAL ADJUSTMENT BY THE DESIGNER.
  17. SHRUBBERY IS TO BE PLANTED AT LEAST 30' FROM CURBING AND FROM END OF PARKING SPACES TO PREVENT DAMAGE FROM CAR OVERHANG.
  18. SHRUBS INSTALLED AS VEHICULAR USE SCREENING ARE TO BE MAINTAINED AT A MIN. HEIGHT OF 6'-0" MIN. INSTALLATION HEIGHT IS 24".
  19. SITE LIGHTING PLANS REQUIRE LIGHTS TO BE A MIN. OF 15 FEET FROM TREES. ANY ADJUSTMENTS IN THE FIELD NEED TO COMPLY WITH THIS STANDARD AND BE APPROVED BY STAFF.
  20. EACH TREE MUST BE PLANTED SUCH THAT THE ROOT FLARE IS VISIBLE AT THE TOP OF THE ROOT BALL. TREES WHERE THE ROOT FLARE IS NOT VISIBLE WILL BE REJECTED. DO NOT COVER THE ROOT FLARE WITH MULCH.
  21. DO NOT PLACE MULCH IN CONTACT WITH THE TREE TRUNK. KEEP MULCH A MIN. OF 4" AWAY FROM THE TRUNK BASE.
  22. ANY CHANGES TO THE PROPOSED PLANT SCHEDULE MUST BE APPROVED BY THE DESIGNER OF RECORD AND STAFF. IN CASES WHERE THE PLANT SCHEDULE ONLY INCLUDES THE PLANT TYPE AND DOES NOT INCLUDE THE PLANT SPECIES, THE CONTRACTOR SHALL BE REQUIRED TO SUBMIT TO THE CITY FOR APPROVAL. A DETAILED PLANT SCHEDULE AND ASSOCIATED PLANTING PLAN PREPARED BY SOMEONE KNOWLEDGEABLE ABOUT PLANT MATERIAL AND DESIGN, PRIOR TO PROCEEDING WITH INSTALLATION.
  23. PROPERTY PERIMETER BUFFER - IN AREAS WHERE EXISTING VEGETATION IS TO BE USED TO SATISFY PERIMETER LANDSCAPE BUFFER, THE CITY MAY DETERMINE, AFTER AN ON-SITE INSPECTION, THAT ADDITIONAL PLANTING IS REQUIRED TO SATISFY THE REQUIRED BUFFER.


LANDSCAPE REQUIREMENTS

CITY OF FAYETTEVILLE LANDSCAPING REQUIREMENTS:

- BUILDING:**  
Perimeter of building additions: 369 LF  
Requirement: 1 shrub per 5 LF = 74  
Shrubs provided: 74
- BUFFER:**  
Buffer length (Southeast property line): 189 LF; (Southwest property line): 184'  
Requirement: Type D: 6' Fence plus 6 Canopy Trees plus 25 shrubs/100 LF  
48 shrubs for southeast p/l; 46 shrubs for southwest p/l  
Trees & shrubs shown indicate this requirement.
- STREET TREES:**  
Improved area along Raeford Road (entrance drive): 86 LF  
Kilmory Drive: 300 LF  
Requirement: 1 canopy tree per 50 LF  
Raeford Road: 2  
Kilmory Drive: 6
- PARKING BAY ENDS:**  
Requirement: 1 shrub per 5 LF  
Plant locations along parking perimeter indicates this requirement.

ADDITIONAL NOTES

1. ALL GENERAL NOTES, ABBREVIATIONS, SYMBOLS, AND OTHER INFORMATION INDICATED ON [SHEET C#.# (OR) TITLE PAGE] SHALL APPLY TO THIS PLAN.

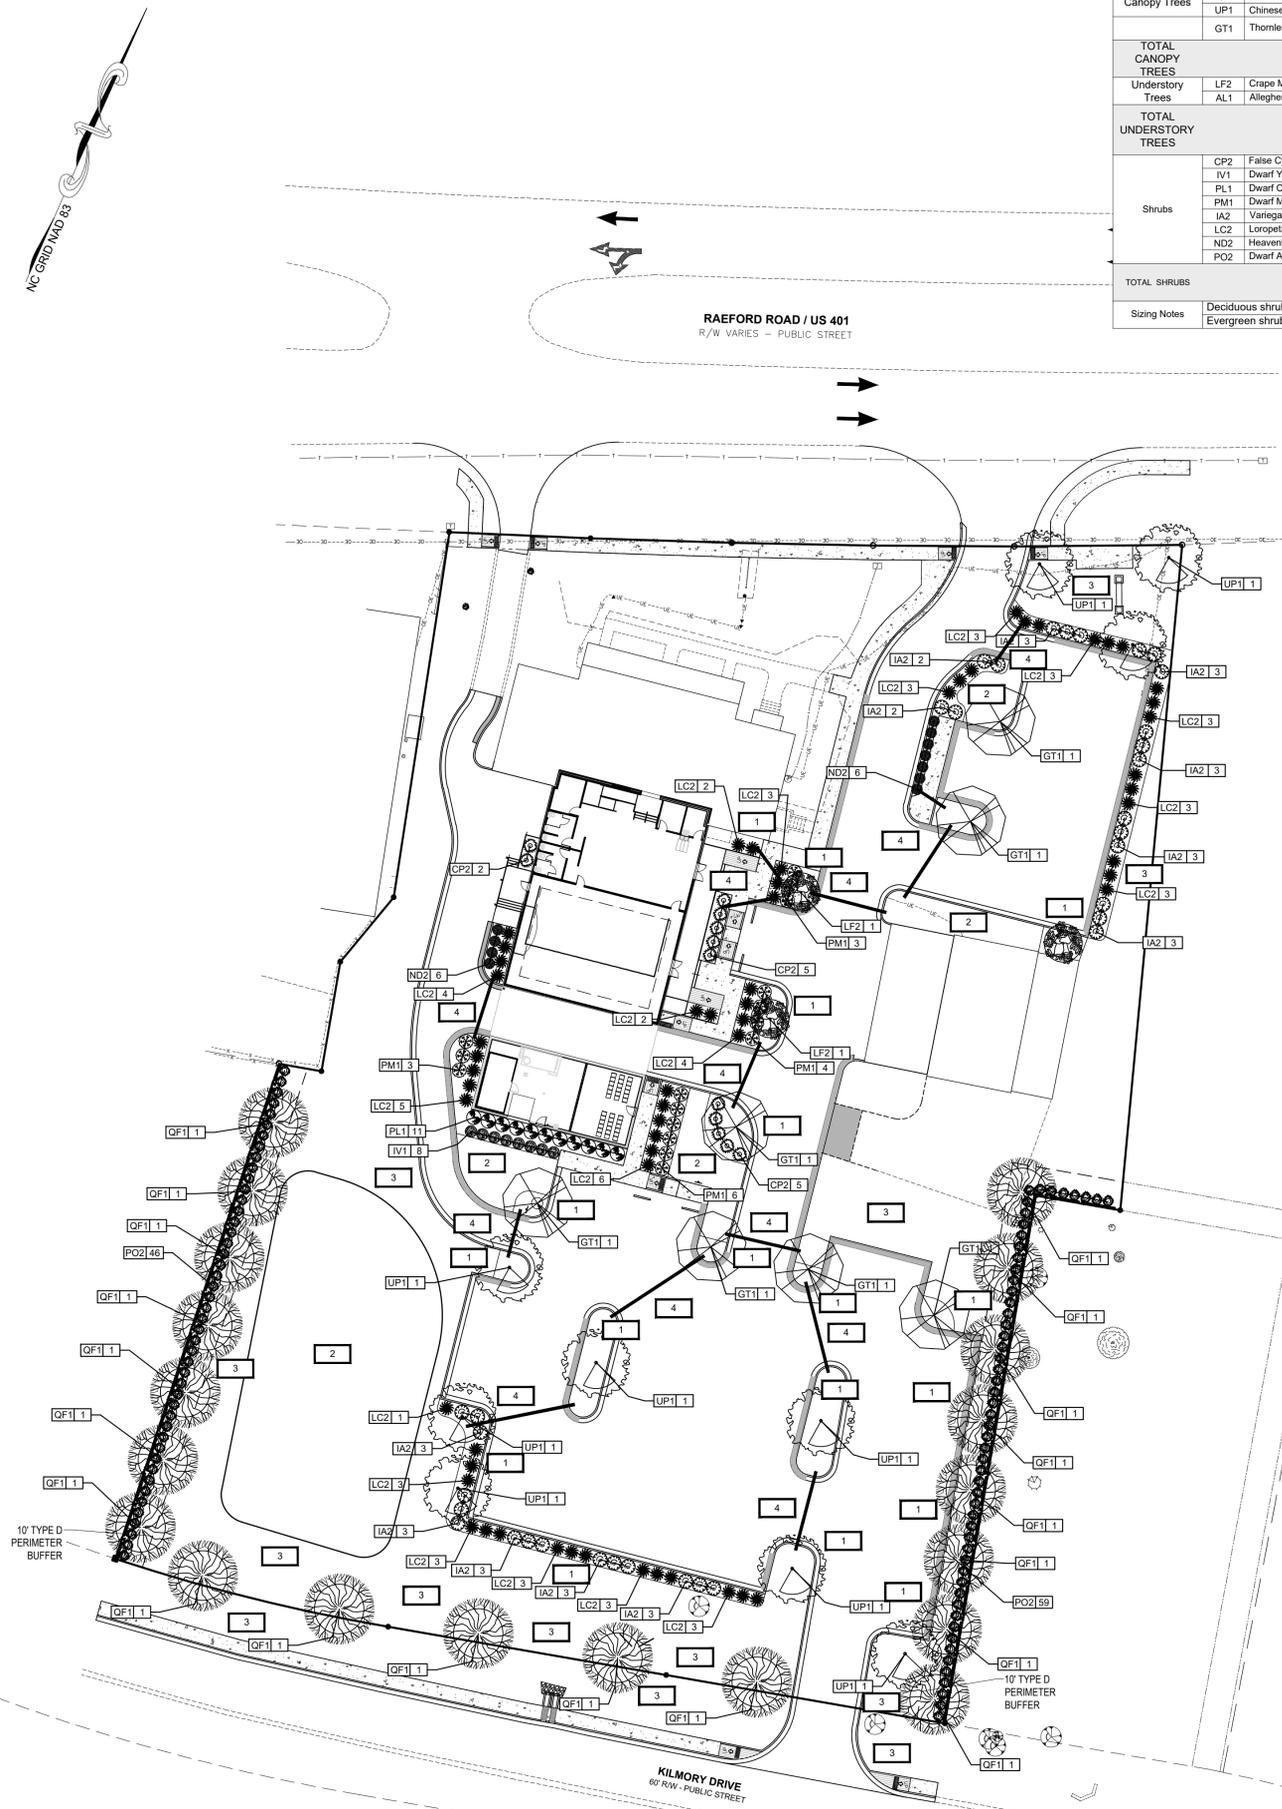

Plant List Reference Table						
Classification	Key	Common Name	Botanical Name	Quantity	Type / Size	Notes
Canopy Trees	QF1	Southern Red Oak	Quercus falcata	20	2' cal., 8' ht. minimum.	Healthy, Well Branched, Full Foliage
	UP1	Chinese Elm	Ulmus parvifolia	10	2' cal., 8' ht. minimum.	Healthy, Well Branched, Full Foliage
	GT1	Thornless Honey Locust	Gleditsia triacanthos f. inermis 'Shademaster'	7	2' cal., 8' ht. minimum.	Healthy, Well Branched, Full Foliage
<b>TOTAL CANOPY TREES</b>				37		
Understory Trees	LF2	Crape Myrtle (Twilight)	Lagerstroemia x fauriei 'Twilight'	3	1.5" cal., 5' ht. minimum.	Healthy, Well Branched, Full Foliage
	AL1	Allegheny Serviceberry	Amelanchier laevis	6	1.5" cal., 5' ht. minimum.	Healthy, Well Branched, Full Foliage
<b>TOTAL UNDERSTORY TREES</b>				9		
Shrubs	CP2	False Cypress (Golden Mop)	Chamaecyparis pisifera 'Golden Mop'	12	See Sizing Notes	Healthy, Full Foliage
	IV1	Dwarf Yaupon Holly	Ilex vomitoria 'Compacta'	8	See Sizing Notes	Healthy, Full Foliage
	PL1	Dwarf Cherry Laurel	Prunus laurocerasus 'Otto Luyken'	11	See Sizing Notes	Healthy, Full Foliage
	PM1	Dwarf Mugo Pine	Pinus mugo 'White Bud'	16	See Sizing Notes	Healthy, Full Foliage
	IA2	Variegated English Holly	Ilex aquifolium english holly 'variegated'	60	See Sizing Notes	Healthy, Full Foliage
	LC2	Loropetalum (Razzleberry)	Loropetalum chinese rubrum 'Razzleberry'	34	See Sizing Notes	Healthy, Full Foliage
Shrubs	ND2	Heavenly Bamboo (Gulf Stream)	Nandina domestica 'Gulf Stream'	11	See Sizing Notes	Healthy, Full Foliage
	PO2	Dwarf Arborvitae (Golden Globe)	Thuja occidentalis 'Golden Globe'	105	See Sizing Notes	Healthy, Full Foliage
<b>TOTAL SHRUBS</b>				257		
Sizing Notes		Deciduous shrubs shall be 24" tall at planting Evergreen shrubs shall be 18" tall at planting				



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PRELIMINARY

REVISIONS	
No.	Description
0	mm-dd-yy

LAFAYETTE FUNERAL HOME  
LAFAYETTE FUNERAL HOME  
BUILDING ADDITION

LANDSCAPE PLANTING PLAN

PROJECT DETAILS  
Project Manager: FDC  
CAD Technician: ILB  
Reviewed / Approved By: FDC  
Project Number: 21006

SCALE: 0 30 60  
Full Scale: Horiz.: 1" = 30'  
ISSUE DATE: 04/22/2021  
SHEET NUMBER

L1.0

F:\21006 Lafayette 3-17-21\Current Plan Set\21006a-L1.0 Landscaping Plan, May, 16, 2021 - 5:02:54 PM



11.30.20

**ROBERT CHARLES EVANS**  
ARCHITECT  
ARCHITECTURE  
545 Pearl Street Fayetteville North Carolina 28303

# Lafayette Funeral Home Addition

**Drawing Name:**  
Exterior Elevations  
Roof Plan

**Project Name:**  
An Addition to  
Lafayette Funeral Home


**Project Location:**  
6651 Raeford Road  
Fayetteville  
North Carolina

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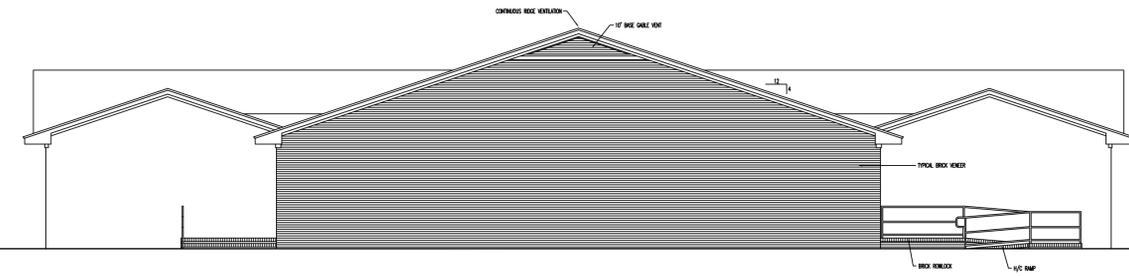
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PROJECT NO: 20-116  
DRAWN BY: RCE,jec  
DATE: 09.22.20  
REVISIONS:


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**A3.1**




01 RIGHT ELEVATION  
1/8" = 1'-0"

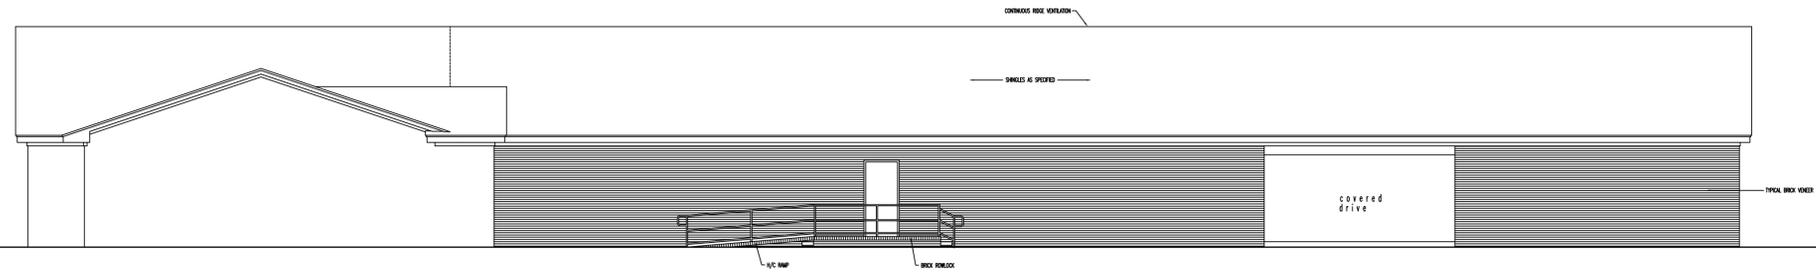

02 REAR ELEVATION  
1/8" = 1'-0"

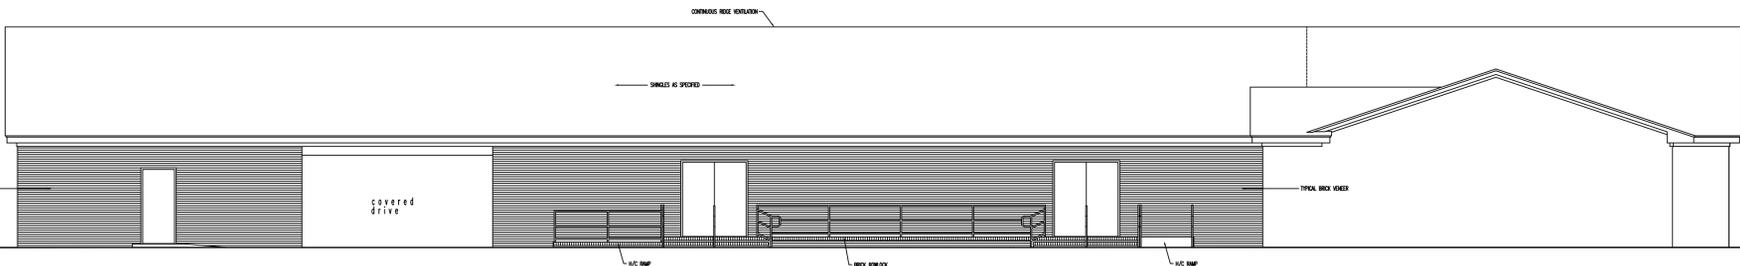

03 LEFT ELEVATION  
1/8" = 1'-0"

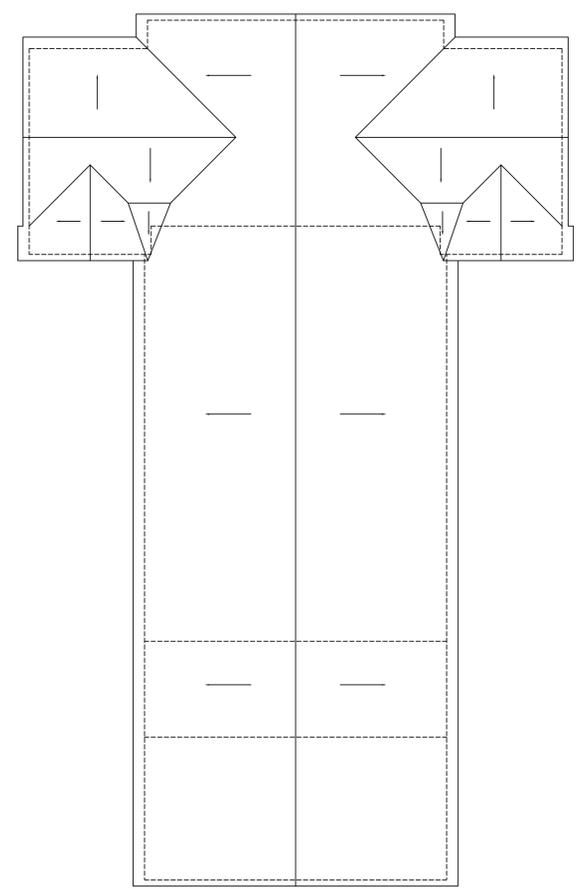

04 ROOF PLAN  
1/16" = 1'-0"